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## RE-ISSUED FOR DEVELOPENT PERMIT March 19, 2024

# **CAR WASH**

for Zen Group

Civic Address: 3180 Island Highway North, Nanaimo

#### **CONSULTANT TEAM**

OWNER: Zen Group

LANDSCAPE: ETA Landscape Architecture

**ARCHITECT: BFA Studio Architects** 

CIVIL: Aplin Martin

Sheet	Drawing Title

Landscape Materials & Grading Plan Landscape Planting Plan Soil Depths & Irrigated Areas Plan

Landscape Details & Sections

**ALL PLANTS TO BE NURSERY GROWN** ALL PLANT MATERIALS AND LABOUR TO CONFORM TO THE CURRENT EDITION OF THE CSLA LANDSCAPE STANDARDS.

#### ALL PLANT MATERIAL TO BE INSPECTED PRIOR TO DELIVERY ON SITE. CONTRACTOR TO ARRANGE FOR INSPECTION AND MATERIAL TO ASSEMBLED IN ONE LOCATION FOR REVIEW.

IMPORTED GROWING MEDIA SHALL BE A SANDY LOAM OR LOAMY SAND TEXTURE (NO LESS THAN 50% SAND BY WEIGHT) CONTAINING 4 AND 15% ORGANINC MATTER (DRY WEIGHT BASIS).

GROWING MEDIA SHALL VIRTUALLY FREE FROM SUBSOIL, WOOD INCLUDING WOODY PLANT PARTS. INVASIVE AND NOXIOUS PLANT AND THEIR REPRODUCTIBLE PARTS, PLANT PATHOGENIC ORGANISMS, ORGANIC OR INORGANIC MATERIALS, TOXINS, STONES OVER 30mm (1,2"), ANY DEBRIS AND FOREIGN OBJECTS.

IMPORTED GROWING MEDIA SHALL CONFORM TO AND BE TREATED AS PER SECTION 6.2.3 TO 6.2.7 INCLUSIVE OF THE CURRENT EDITION CSLA LANDSCAPE STANDARDS.

GROWING MEDIUM SHALL CONFORM TO LEVEL 1 "WELL-GROOMED" AREAS: LOW TRAFFIC LAWN AREAS, TREES AND LARGE SHRUBS (1L IN TABLE T-6.3.5.1 OF THE CURRENT EDITION OF THE CSLA LANDSCAPE STANDARDS).

### **TEXTURE**

\*COARSE GRAVEL (LARGER THAN 19mm AND SMALLER THAN 40mm): 0-1% \*ALL GRAVEL (LARGER THAN 2mm AND SMALER THAN 40mm): 0-5% \*SAND (LARGER THAN 0.05mm AND SMALLER THAN 2mm): 50-70% \*SILT (LARGER THAN 0.002mm AND SMALLER THAN 0.05mm): 10-25% \*CLAY (SMALLER THAN 0.002mm): 0-20% \*CLAY AND SILT COMBINED: MAXIMUM 25%

#### **ORGANIC CONTENT: 3-10%**

#### Acidity (pH): 6.0-7.0 as per CSLA Standards

IT SHALL POSSESS THE FOLLOWING QUALITIES:

**DRAINAGE**: PERCOLATION SHALL BE SUCH THAT NO STANDING WATER IS VISIBLE 60 MINUTES AFTER AT LEAST 10 MINUTES OF MODERATE TO HEAVY RAIN OR IRRIGATION.

MINIMUM SOIL DEPTH TO BE AS PER TABLE T 6.3.5.5 OF THE CURRENT EDITION CSLA LANDSCAPE STANDARDS:

subg	r prepared grade where the soil drains rapidly	Over structures or where the subsoil drains poorly		
LARGE TREE TREES (10m3 PER TREE) LARGE SHRUBS SMALL SHRUBS GROUNDCOVERS LAWN-IRRIGATED LAWN-NOT IRRIGATED	750mm(30") 600mm (24") 600mm(24") 450mm(18") 300mm(12") 150mm(6")	900mm(35") 750mm(30") 500-900mm(20"-36") 300-500mm(12"-20") 225mm(9") 150mm(6") 225mm(9")		

#### SOIL DEPTHS WILL BE CHECKED AT TIME OF SUBSTANTIAL COMPLETION REVIEW

SOIL FOR URBAN AGRICULTURE PLOTS IS TO BE URBAN GRO PROVIDED BY VERATEC, OR APPROVED ALTERNATIVE. SOIL FOR URBAN AGRICULTURE AREAS IS TO MEET OR EXCEED THE GUIDELINES FOR COMPOST QUALITY UNDER CANADIAN COUNCIL OF MINISTERS OF THE ENVIRONMENT (CCME).

COMPOST IS TO BE TESTED AND RESULTS SUBMITTED TO CONSULTANT PRIOR TO DELIVERY TO SITE.

BEDS TO HAVE 3" MULCH LAYER (after settling) CONSISTING OF ORGANIC COMPOSTED BARK APPLIED.

PLANTED AREAS TO HAVE PERMANENT HIGH EFFICIENCY IRRIGATION SYSTEM - SHOP DRAWINGS ARE TO BE PREPARED BY AN IABC CERTIFIED DESIGNER AND APPROVED BY LANDSCAPE ARCHITECT.

CONTRACTOR TO PROVIDE MAINTENANCE FOR 1 YEAR FOLLOWING SUBSTANTIAL COMPLETION.

CONTRACTOR TO PROVIDE WRITTEN 1 YEAR WARRANTY ON PLANT MATERIAL

CONTRACTOR TO PROVIDE COPY OF SOIL TEST TO LANDSCAPE CONSULTANT 3 WEEKS **PRIOR** TO DELIVERY ON-SITE. TEST TO BE PERFORMED BY AN INDEPENDENT LAB AND IS TO INCLUDE RECOMMENDATIONS FOR BOTH LAWN AND PLANTING BEDS.

CONSULTANT TO APPROVE SOIL BEFORE INSTALLATION. THIS DOES NOT PRECLUDE THE CONSULTANT FROM PERFORMING AN INDEPENDENT SOIL ANALYSIS AT TIME OF SUBSTANTIAL COMPLETION. CONTRACTOR WILL BE RESPONSIBLE FOR REMOVAL AND REPLACEMENT OF SOIL THAT DOES NOT MEET SPECIFICATIONS AT NO EXTRA COST TO CLIENT.

CONTRACTOR TO PROVIDE WRITTEN 1 YEAR WARRANTY ON SOIL SPECIFICATIONS.

AN INDEPENDENT SOIL TEST TO BE PROVIDED 1 WEEK PRIOR TO END OF 1 YEAR WARRANTY PERIOD CONTRACTOR TO PROVIDE SOIL AMMENDMENTS TO BRING SOIL UP TO QUALITY RECOMMENDED IN SOILS REPORT.

## SITE INSPECTION

EXAMINE EXISTING SUBGRADE CONDITIONS AND SIGNIFY ACCEPTANCE IN WRITING TO THE CONSULTANT.

ASCERTAIN THE SIZE AND LOCATION OF ALL EXISTING SERVICES AND SUBGRADES PRIOR TO THE

IMMEDIATELY REPAIR DAMAGE RESULTING FROM FAILURE TO EXERCISE SUCH PRECAUTIONS AT NO COST TO THE OWNER.

ALL PRUNING TO BE IN ACCORDANCE WITH THE CSLA LANDSCAPE STANDARDS CURRENT EDITION.

ALL SOFTSCAPE AREAS TO INCLUDE MIN. 75MM GRAVEL DRAINAGE LAYERS IN ADDITION TO INDICATED SOIL DEPTH.

## PLANT COUNTS

IN THE CASE OF ANY DISCREPANCY BETWEEN PLANT COUNTS ON PLANT LIST AND PLANT SYMBOLS ON DRAWING, THE DRAWINGS TAKES PRECEDENT. THE CONTRACTOR IS TO VERIFY ALL PLANT COUNTS AND NOTIFY CONSULTANT OF ANY DISCREPANCY.

## **BIRD FRIENDLY PLANTING**

PLANTS THAT ENABLE BIRD-FRIENDLY HABITAT CONSERVATION AND PROMOTION HAVE BEEN SELECTED AND CAN BE FOUND THROUGHOUT THE LANDSCAPE. PLANTING IS GROUPED IN NATURALIZED LAYERS OF TREES, TALL SHRUBS, LOW SHRUBS AND GROUNDCOVERS, MIMICKING THE IDEAL ENVIRONMENTAL CONDITIONS FOR BIRDS. THESE LAYERS WILL BE VARIED WITH A DIVERSITY OF TEXTURES AND DENSITIES THAT ATTRACTS AND PROTECTS MANY BIRD SPECIES. SPECIFIC LOCAL AND NON-INVASIVE PLANT SPECIES HAVE BEEN SELECTED BASED ON THEIR ABILITY TO PROVIDE YEAR- ROUND FOOD FOR BIRDS AND/OR YEAR-ROUND NESTING OPPORTUNITIES.

### **GENERAL NOTES**

1.DO NOT SCALE DIRECTLY FROM DRAWINGS 2. WHERE PLANS AND SPECIFICATIONS ARE FOUND TO BE IN CONFLICT, OR WHERE VARIOUS

ITEMS OF WORK ARE SEEN TO BE IN CONFLICT, NOTIFY THE CONSULTANT IN WRITING IMMEDIATELY, PRIOR TO COMMENCING CONSTRUCTION.

3.THE CONTRACTOR IS REQUIRED TO INVESTIGATE AND VERIFY THE ALIGNMENT AND LOCATION OF ALL EXISTING SERVICES AND ALL EXISTING LANDSCAPE FEATURES ON SITE PRIOR TO COMMENCING CONSTRUCTION.

4.THE CONTRACTOR SHOULD PROVIDE SHOP DRAWINGS FOR REVIEW PRIOR TO COMMENCEMENT OF LANDSCAPE WORKS. MOCK UPS MAY BE REQUIRED AS NOTED/REQUESTED. 5.DIMENSIONS ON THIS DRAWING ARE IN MM, UNLESS OTHERWISE STATED AS REQUIRED BY THE

6.THESE DRAWINGS SHOULD BE READ IN CONJUNCTION WITH CORRESPONDING ARCHITECTURE AND CIVIL ENGINEER'S DRAWINGS. 7.VERIFY LOCATION OF ALL UNDERGROUND STRUCTURES INCLUDING, BUT NOT LIMITED TO, VAULTS, ELECTRICAL DUCT BANKS, MANHOLES, CONDUITS AND PIPING, DRAINAGE STRUCTURES AND OTHER UTILITIES WITH CORRESPONDING WET AND DRY ENGINEER'S AND CIVIL DRAWINGS. 8.ALL VEHICULAR ROADS SUB LAYERS TO BE READ FROM GEOTECHNICAL SPECIFICATIONS.
9.THE CONTRACTOR IS RESPONSIBLE FOR REPAIRING ALL WORK DISTURBED BY CONSTRUCTION OUTSIDE OF LIMIT LINES DEFINED ON DRAWINGS OR THROUGH HIS/HER MEANS AND METHODS TO A CONDITION BETTER THAN OR EQUAL TO THE EXISTING CONDITIONS PRIOR TO

COMMENCEMENT OF CONSTRUCTION AT NO ADDITIONAL COST TO THE OWNER.

10. FOR PHASED PROJECT, A SOIL TEST SUBMITTAL WILL BE REQUIRED AT EACH PHASE AND THE TEST IS TO BE WITHIN 3 WEEKS OF THE DELIVERY TO SITE.

#### PLANTING NOTES- REFER TO CURRENT NOTES LIST.

1.THE CONTRACTOR SHALL INSTALL TREE PROTECTION FENCE AS INDICATED ON THE DRAWINGS OR ARBORIST REPORT IN COMPLIANCE WITH ALL MUNICIPAL AND PROFESSIONAL REQUIREMENTS 2.TREE PROTECTION TO REMAIN IN PLACE UNTIL ALL CONSTRUCTION IS COMPLETE. 3.DO NOT STORE CONSTRUCTION MATERIALS, DEBRIS, EXCAVATED MATERIAL OR EQUIPMENT WITHIN TREE PROTECTION ZONE.

4.FINISH GRADING SHALL MEET EXISTING GRADE OF PROTECTED TREES 0.5M OR (20 INCHES) BEYOND THE DRIPLINE.

5.EXACT LOCATIONS OF PROPOSED PLANT MATERIALS SHALL BE FLAGGED / STAKED AND APPROVED BY LANDSCAPE ARCHITECT CONSULTANT ON SITE PRIOR TO INSTALLATION. THE LANDSCAPE ARCHITECT RESERVES THE RIGHT TO ADJUST PLANTS ON SITE. 6.LANDSCAPE ARCHITECT RESERVES THE RIGHT TO REJECT UNSUITABLE MATERIAL DELIVERED OR INSTALLED ON SITE WITHOUT PRIOR REVIEW AND APPROVAL

7.THE CONTRACTOR SHALL OBTAIN AN AGRONOMIC SOIL ANALYSIS REPORT, WHICH TESTS THE SOIL QUALITY CRITERIA RELATIVE TO - AGRICULTURE BY AN CERTIFIED SOIL NUTRIENT TESTING LABORATORY FOR APPROVAL BY THE LANDSCAPE ARCHITECT. THE REPORT SHALL INCLUDE RECOMMENDATIONS FOR PREPARATION OF GROWING MEDIUM TO MEET THE CSLA AAPC & CNLA

8.EXCESS SOIL FROM LANDSCAPE GRADING IS TO BE REMOVED AND DISPOSED OF OFFSITE BY THE CONTRACTOR IN A LOCATION APPROVED BY THE DEPARTMENTAL REPRESENTATIVE. 9.REFER TO PLANT SCHEDULE FOR THE LIST OF SPECIES, INCLUDING SIZE AND FORM AND OTHER SPECIFIED INFO. 10.CONTRACTOR TO OBTAIN APPROVAL OF LANDSCAPE ARCHITECT FOR ANY SUBSTITUTIONS OF

PLANT SPECIES OR SIZES. 11.ALL TREES MUST BE GUYED OR STAKED AS PER DETAILS AND SPECIFICATIONS. 12.THE CONTRACTOR SHALL PROVIDE ROOT BARRIERS FOR ALL TREES LOCATED WITHIN TWO (2.0) METERS OF PAVING OR UNDERGROUND UTILITIES.

13.THE CONTRACTOR SHALL MANUALLY IRRIGATE OR ACTIVATE IRRIGATION SYSTEMS NECESSARY TO WATER AND MAINTAIN PROPOSED AND EXISTING VEGETATION. 14.FOR PLANTING SOIL DEPTH, FOLLOW THE CITY'S RECOMMENDATION AND REQUIREMENTS ONLY IF THE CITY'S REQUIREMENTS FOR SOIL DEPTH EXCEEDS CSLA OR BCSLA STANDARDS AND REQUIREMENTS.

15. A SHOP DRAWING INDICATING THE SOIL DEPTH TO BE PROVIDED FOR THE LANDSCAPE REVIEW PRIOR TO INSTALLATION. 16. LIGHT-WEIGHT-BLOWN-IN SOIL WILL NOT BE ACCEPTED UNLESS IT IS REQUIRED BY STRUCTURAL ENGINEER.

17. A LANDSCAPE ARCHITECT SHALL BE ON SITE AT SOIL DELIVERY DATE.

#### HARD LANDSCAPE & FURNITURE NOTES

1.PROVIDE EXPANSION JOINTS ALIGNED WITH PROPOSED PAVING PATTERN AND PAVING MODULES. THE SPACING OF EXPANSION JOINTS TO STRUCTURAL ENGINEERS RECOMMENDATION. 2.UNLESS SPECIFICALLY DIMENSIONED SITE FURNITURE LOCATIONS ON DRAWINGS ARE APPROXIMATE AND MUST BE APPROVED ON SITE BY THE LANDSCAPE ARCHITECT BEFORE UNDERTAKING INSTALLATION.

3.CONTRACTOR TO SUBMIT ENLARGED DETAILED PLANS AND SHOP DRAWINGS FOR ALL HARDSCAPE MATERIAL PAVING, CLADDING AND CAPPING SHOWING PATTERNS, EXACT DIMENSIONS AND ARRANGEMENT FOR LANDSCAPE ARCHITECT'S APPROVAL 4.ALL PAVING MATERIALS COLORS AND FINISHES ARE AS INDICATED ON DRAWINGS AND SPECIFICATIONS OR AS APPROVED BY THE LANDSCAPE ARCHITECT. 5.CONTRACTOR TO BUILD A 2M LONG X MINIMUM WIDTH OR 2M WIDTH (WHICH EVER IS LESS) OCK-UP FOR ALL HARDSCAPE MATERIALS AS SPECIFIED ON DRAWINGS AND SPECIFICATIONS SETS FOR LANDSCAPE ARCHITECT'S APPROVAL PRIOR TO INSTALLATION ON SITE. APPROVED MOCK-UPS COULD STAY AS PART OF THE OVERALL HARDSCAPE INSTALLATIONS. 6.ALL SITE FURNITURE COLORS AND FINISHES IS AS INDICATED ON DRAWINGS AND SPECIFICATIONS OR AS APPROVED BY THE LANDSCAPE ARCHITECT. 7.CONTRACTOR TO FOLLOW MANUFACTURER RECOMMENDATIONS FOR INSTALLATION AND

## ARCHITECT'S APPROVAL.

SITE LAYOUT & GRADING NOTES 1.ALL PROPOSED DIMENSIONS SHALL BE VERIFIED ON SITE BEFORE PROCEEDING WITH CONSTRUCTION.

FIXATION OF ALL SITE FURNITURE AND TO SUBMIT SHOP DRAWINGS FOR LANDSCAPE

2.SITE LAYOUT DIMENSIONS ARE IN M. UNLESS OTHERWISE INDICATED. 3.ALL PROPOSED LEVELS SHALL BE VERIFIED ON SITE BEFORE PROCEEDING WITH CONSTRUCTION.

4.STAIRS NUMBERS AND RISERS HEIGHT SHOULD BE VERIFIED ON SITE AND ADJUSTED AS SEEN NECESSARY AND AS APPROVED BY ENGINEER. 5.CONTRACTOR TO CROSS CHECK ALL EXTERNAL WORKS LEVELS WITH EXISTING BUILDINGS. ANY DISCREPANCIES TO BE SUBMITTED FOR THE LANDSCAPE ARCHITECT'S FEEDBACK

6.DIMENSIONS TAKE PRECEDENCE OVER SCALE SHOWN ON DRAWINGS 7.FOR LAYING OF ROADS AND CAR PARKING AND ASSOCIATED DRAINAGE REFER TO ENGINEER'S DRAWINGS AND SPECIFICATIONS. 8.THE FINISH GRADING OF PLANTING AREAS SHALL BE 50MM BELOW ADJACENT CURB OR

#### IRRIGATION NOTES 1. IRRIGATION TO BE PROVIDED FOR ALL SOFT LANDSCAPE AREAS SHOWN ON THE DRAWING, BY

LANDSCAPE CONTRACTOR. 2. IRRIGATED AREAS TO BE INSTALLED AS A DESIGN BUILD IRRIGATION SYSTEM FROM THE STUB OUTS PROVIDED (TYP. 2", CONFIRM WITH MECHANICAL). PROVIDE SUBMITTALS OF DESIGN FOR LANDSCAPE REVIÈW AT LEAST ONE WEEK PRIOR TO INSTALLATION AND AS-BUILT DRAWING WITHIN ONE MONTH OF SUBSTANTIAL PERFORMANCE, TO INCLUDE SLEEVING, DRIP LINE, PIPE SIZE, VALVE BOXES, ETC. VALVE BOXES TO BE LOCATED IN LOW-VISIBLE PLANTED AREAS ONLY AND LOCATIONS TO BE APPROVED.

3. IRRIGATION SYSTEM DESIGN AND INSTALLATION SHALL BE IN ACCORDANCE WITH CANADIAN LANDSCAPE STANDARDS. 4. IRRIGATION CONTRACTOR PERFORMING THE WORK MUST HAVE MINIMUM (5) FIVE YEARS DOCUMENTED EXPERIENCE, AND BE A MEMBER IN GOOD STANDING OF THE IIABC (IRRIGATION INDUSTRY ASSOCIATION OF BC)

5. IRRIGATION TO CONFORM TO ALL LOCAL PLUMBING AND ELECTRICAL CODE REQUIREMENTS. CONTRACTOR IS RESPONSIBLE FOR COORDINATION WITH MECHANICAL AND ELECTRICAL CONSULTANTS AND TRADES.

6. IRRIGATION STUB-OUTS AND HOSE BIBS PER MECHANICAL PLANS. 7. SEPARATE ZONE AND REQUIRED SLEEVES TO BE PROVIDED FOR SPRAY IRRIGATION OF OFFSITE AREAS, PER CITY STANDARDS.

8. ALL IRRIGATION VALVE BOXES TO BE QUIPPED WITH QUICK COUPLERS. 9. TEST SYSTEM PRIOR TO COMPLETION OF LANDSCAPE WORKS TO ENSURE NO LEAKAGE AND SPECIFIED PSI IS MET. PROVIDE WRITTEN NOTICE THAT PRESSURE TESTING HAS MET STANDARDS.

10. MAINTAIN AND OPERATE IRRIGATION PER MANUFACTURER'S RECOMMENDATIONS THROUGHOUT WARRANTY PERIOD - WINTERIZE AS REQUIRED. 11. PROVIDE COPIES OF INSTRUCTION MANUALS FOR OPERATION AND MAINTENANCE OF SYSTEM AND CONTROLS, SEASONAL ACTIVITY, AND SHUTDOWN AND MANUFACTURER'S PARTS CATALOGUE.

## LANDSCAPE LIGHTING NOTES

1.ALL LIGHTING POINTS SHOWN ON LANDSCAPE PLANS ARE FOR REFERENCE ONLY. FOR ALL LIGHTING FIXTURES AND TYPES, REFER TO ELECTRICAL DRAWINGS AND SPECIFICATIONS. 2.CONTRACTOR TO SUBMIT SAMPLES OF ALL LIGHT FIXTURES WITH REFERENCE SPECS AND PHOTOMETRIC'S TO THE LANDSCAPE ARCHITECT FOR REVIEW AND APPROVAL PRIOR TO

INSTALLATION ON SITE 3.FOR STREET LIGHTING LOCATIONS AND TYPES REFER TO CIVIL DRAWINGS AND SPECIFICATIONS.

4.LIGHTING SPECS TO BE COORDINATED AND REVIEWED WITH ELECTRICAL PRIOR TO CONSTRUCTION. 5.STREET TREES AND FURNISHINGS TO BE LOCATED AT ACCEPTABLE OFFSITE- REFER TO LAYOUT DRAWINGS AND MUNICIPAL STANDARDS

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Project

## Car Wash


3180 Island Highway North Nanaimo

Drawing Title

## Cover Sheet

## RECEIVED 2024-APR-02 Current Planning

KD 22318 Drawn By N/A KD Reviewed By

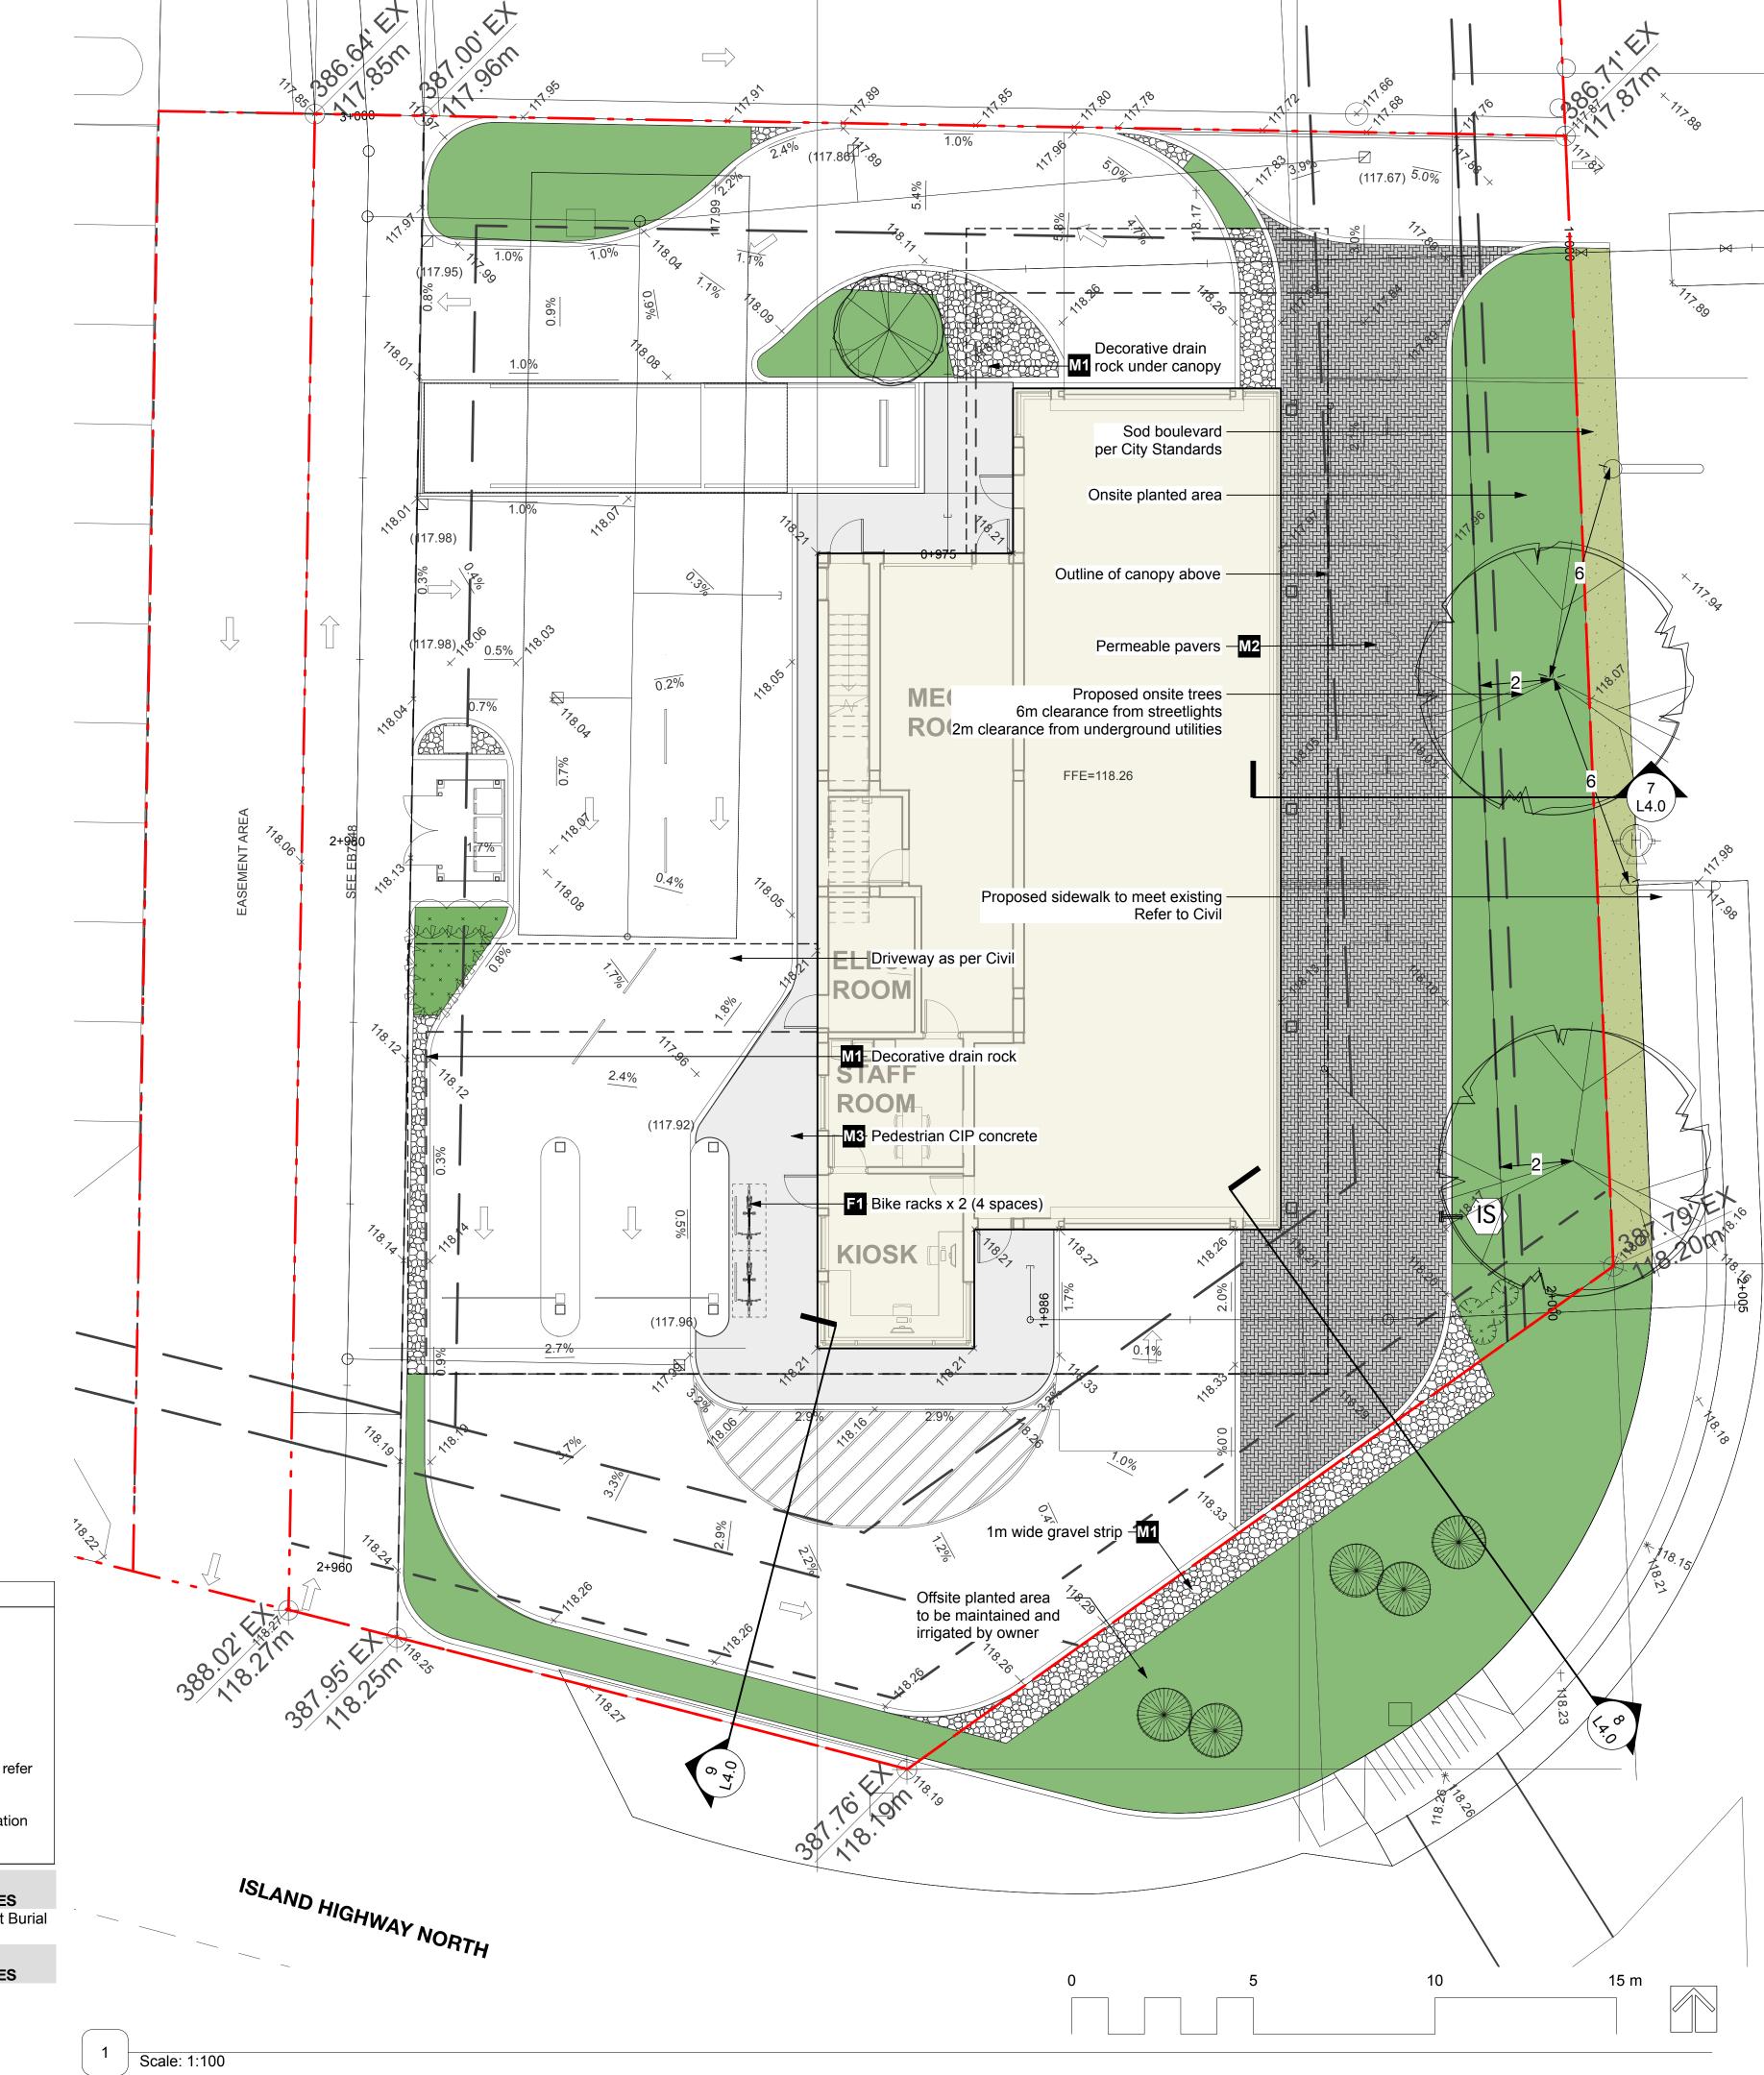

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Car Wash

3180 Island Highway North Nanaimo

Drawing Title

Landscape Materials & Grading Plan

> RECEIVED **DP1324** 2024-APR-02 Current Planning

Project Manage 22318 Drawn By 1:100 Reviewed By L1.0

**IRRIGATED AREAS & SERVICING LEGEND** 

Irrigation Stub-out

\*All onsite planted areas to be irrigated.\* Offsite planting irrigated as noted.

Refer to canadian landscape standard, typ.
 This sheet is for reference only, Contractor to refer

to Irrigation drawings for the Irrigation design.
3. Final locations per Mechanical. 4. Shop drawings to be provided prior to installation

for Landscape review.

MATERIALS AND FURNISHINGS


SITE FURNISHINGS ID DETAIL DESCRIPTION SIZE COLOUR MATERIAL MODEL MANUFACTURER QTY NOTES MBR-0500-00001 Maglin F1 1/L2.0 Bike Rack 2x19x35" Red 2 Direct Burial

**MATERIALS** ID DETAIL DESCRIPTION SIZE COLOUR PATTERN MODEL MANUFACTURER QTY NOTES M1 6/L2.0 Decorative Drain Rock 2-3" dia NW Landscape - -

M2 4/L2.0 Permeable Paver 4x8x3" Gray Herringbone Eco Priora Mutual Materials - -M3 5/L2.0 CIP Pedestrian Concrete -

NOTE: IN THE EVENT OF A DISCREPANCY BETWEEN THE SITE FURNISHINGS, MATERIALS, AND LIGHTING SCHEDULE QUANTITIES AND THE LANDSCAPE PLANS, THE LANDSCAPE PLANS TAKE PRECEDENCE.

## **PLANT PALETTE**

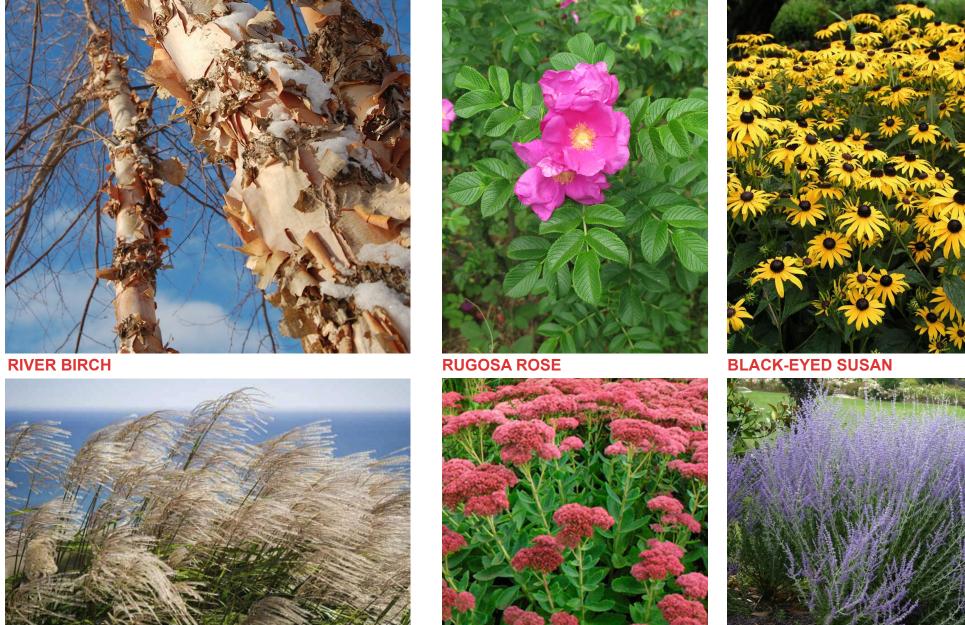



**DWARF STRAWBERY MADRONE** 

## DI ANT LIST

**MAIDEN GRASS** 

LIST						
QTY	LATIN NAME	COMMON NAME	SPACING	SIZE	NOTES	<b>ATTRIBUTES</b>
S						
2	Betulus nigra 'Heritage'	heritage river birch	as shown	6cm cal/B&B	multistem	
5	Pinus nigra 'Arnold Sentinel'	Arnold Sentinel Austrian pir	nas shown	3m ht/B&B	full/ bushy canopy	E, S
1	Populus tremula 'Erecta'	Swedish columnar aspen	as shown	6cm cal/B&B	2m standard	N
JBS / G	ROUNDCOVERS / PERENNIALS					
20	Arbutus unedo 'Compacta'	dwarf strawberry madrone	1.37	#10 cont.	full/ bushy plants	E, B, P, Ed, W
28	Choisya x dewitteana 'Aztec Pearl'	Aztec Pearl mock orange	1.07	#5 cont.	full/ bushy plants	E, P
117	Lonicera pileata	box leaf honeysuckle	0.91	#3 cont.	full/ bushy plants	E, B, P
36	Miscanthus sinensis 'Gracillimus'	maiden grass	0.91	#5 cont.	full/ bushy plants	B, W
36	Perovskia 'Blue Spire'	Russian sage	0.61	#2 cont.	full/ bushy plants	Р
40	Rudbeckia fulgida 'Goldsturm'	black-eyed Susan	0.46	#1 cont.	full/ bushy plants	B, P
28	Rosa rugosa	rugosa rose	0.91	#3 cont.	full/ bushy plants	B, P
451	Sedum 'Autumn Joy'	autumn stonecrop	0.46	#1 cont.	full/ bushy plants	P, W
0	- -		0			
	QTY S 2 5 1 JBS / G 20 28 117 36 36 40 28 451	QTY LATIN NAME  S  2 Betulus nigra 'Heritage' 5 Pinus nigra 'Arnold Sentinel' 1 Populus tremula 'Erecta'  JBS / GROUNDCOVERS / PERENNIALS 20 Arbutus unedo 'Compacta' 28 Choisya x dewitteana 'Aztec Pearl' 117 Lonicera pileata 36 Miscanthus sinensis 'Gracillimus' 36 Perovskia 'Blue Spire' 40 Rudbeckia fulgida 'Goldsturm' 28 Rosa rugosa 451 Sedum 'Autumn Joy'	QTY LATIN NAME  2 Betulus nigra 'Heritage' heritage river birch 5 Pinus nigra 'Arnold Sentinel' Arnold Sentinel Austrian pir 1 Populus tremula 'Erecta' Swedish columnar aspen  DBS / GROUNDCOVERS / PERENNIALS 20 Arbutus unedo 'Compacta' dwarf strawberry madrone 28 Choisya x dewitteana 'Aztec Pearl' Aztec Pearl mock orange 117 Lonicera pileata box leaf honeysuckle 36 Miscanthus sinensis 'Gracillimus' maiden grass 36 Perovskia 'Blue Spire' Russian sage 40 Rudbeckia fulgida 'Goldsturm' black-eyed Susan 28 Rosa rugosa rugosa rugosa rose 451 Sedum 'Autumn Joy' autumn stonecrop	QTY LATIN NAME  2 Betulus nigra 'Heritage' heritage river birch as shown 5 Pinus nigra 'Arnold Sentinel' Arnold Sentinel Austrian pinas shown 1 Populus tremula 'Erecta' Swedish columnar aspen as shown  20 Arbutus unedo 'Compacta' dwarf strawberry madrone 21 Choisya x dewitteana 'Aztec Pearl' Aztec Pearl mock orange 22 Choisya x dewitteana 'Aztec Pearl' Aztec Pearl mock orange 33 Miscanthus sinensis 'Gracillimus' maiden grass 34 Perovskia 'Blue Spire' Russian sage 35 Rusa rugosa 36 Rosa rugosa 37 Rusona rugosa rose 38 Rosa rugosa 39 Perovskia 'Sedum 'Autumn Joy' autumn stonecrop 30 Perovskia 'Sedum 'Autumn Joy'	Arnold Sentinel Austrian pinas shown 6cm cal/B&B  Bestulus nigra 'Heritage' heritage river birch as shown 6cm cal/B&B  Pinus nigra 'Arnold Sentinel' Arnold Sentinel Austrian pinas shown 3m ht/B&B  Wedish columnar aspen as shown 6cm cal/B&B  Bestulus nigra 'Heritage' heritage river birch as shown 3m ht/B&B  Arnold Sentinel Austrian pinas shown 3m ht/B&B  Swedish columnar aspen as shown 6cm cal/B&B  Bestulus nigra 'Heritage' heritage river birch as shown 6cm cal/B&B  Arnold Sentinel Austrian pinas shown 3m ht/B&B  Swedish columnar aspen as shown 6cm cal/B&B  Bestulus nigra 'Heritage' heritage river birch as shown 6cm cal/B&B  Arnold Sentinel Austrian pinas shown 3m ht/B&B  Swedish columnar aspen as shown 6cm cal/B&B  Bestulus nigra 'Heritage' heritage river birch as shown 6cm cal/B&B  Arnold Sentinel Austrian pinas shown 3m ht/B&B  Swedish columnar aspen as shown 6cm cal/B&B  Bestulus nigra 'Heritage' heritage river birch as shown 6cm cal/B&B  Arnold Sentinel Austrian pinas shown 3m ht/B&B  Swedish columnar aspen as shown 6cm cal/B&B  Arnold Sentinel Austrian pinas shown 3m ht/B&B  Bestulus nigra 'Heritage' heritage river birch as shown 6cm cal/B&B  Arnold Sentinel Austrian pinas shown 3m ht/B&B  Swedish columnar aspen as shown 6cm cal/B&B  Arnold Sentinel Austrian pinas shown 3m ht/B&B  Bestulus nigra 'Heritage' heritage river birch as shown 6cm cal/B&B  Arnold Sentinel Austrian pinas shown 3m ht/B&B  Bestulus nigra 'Heritage' heritage river birch as shown 6cm cal/B&B  Arnold Sentinel Austrian pinas shown 3m ht/B&B  Bestulus nigra 'Heritage' heritage river birch as shown as shown 6cm cal/B&B  Bestulus nigra 'Heritage' heritage river birch as shown as shown 6cm cal/B&B  Bestulus nigra 'Heritage' heritage river birch as shown as sh	Arnold Sentinel Austrian pinas shown 6cm cal/B&B full/ bushy canopy 1 Populus tremula 'Erecta' Swedish columnar aspen as shown 6cm cal/B&B full/ bushy canopy 2 Arbutus unedo 'Compacta' dwarf strawberry madrone 2 Choisya x dewitteana 'Aztec Pearl' Aztec Pearl mock orange 117 Lonicera pileata box leaf honeysuckle 3 Miscanthus sinensis 'Gracillimus' maiden grass 4 Rusbian sage 4 Rudbeckia fulgida 'Goldsturm' black-eyed Susan 4 Sedum 'Autumn Joy' autumn stonecrop 5 Pinus nigra 'Heritage' heritage river birch as shown 6cm cal/B&B multistem 6 Miscanthom Size multistem 7 Moth Sage multistem 7 Moth Sage multistem 8 Miscanthom Sage multistem 9 Mis

- 1 ALL LANDSCAPE TO CONFORM TO THE CURRENT EDITION OF THE CSLA STANDARDS FOR LEVEL 1 'GROOMED' LANDSCAPE TREATMENT IN THE EVENT OF A DISCREPANCY BETWEEN THE PLANT LIST AND THE PLANTING PLAN, THE PLANTING PLAN TAKES PRECEDENCE.

- METRO VANCOUVER IN A CHANGING CLIMATE 4 IN THE CASE OF ANY DISCREPANCY BETWEEN PLANT COUNTS ON PLANT LIST AND PLANT SYMBOLS ON DRAWING, THE DRAWINGS TAKES PRECEDENT. THE CONTRACTOR IS TO VERIFY ALL PLANT COUNTS AND NOTIFY CONSULTANT OF ANY DISCREPANCY.



RECEIVED


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22318

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eto landscape architecture

Car Wash

3180 Island Highway North Nanaimo

Drawing Title

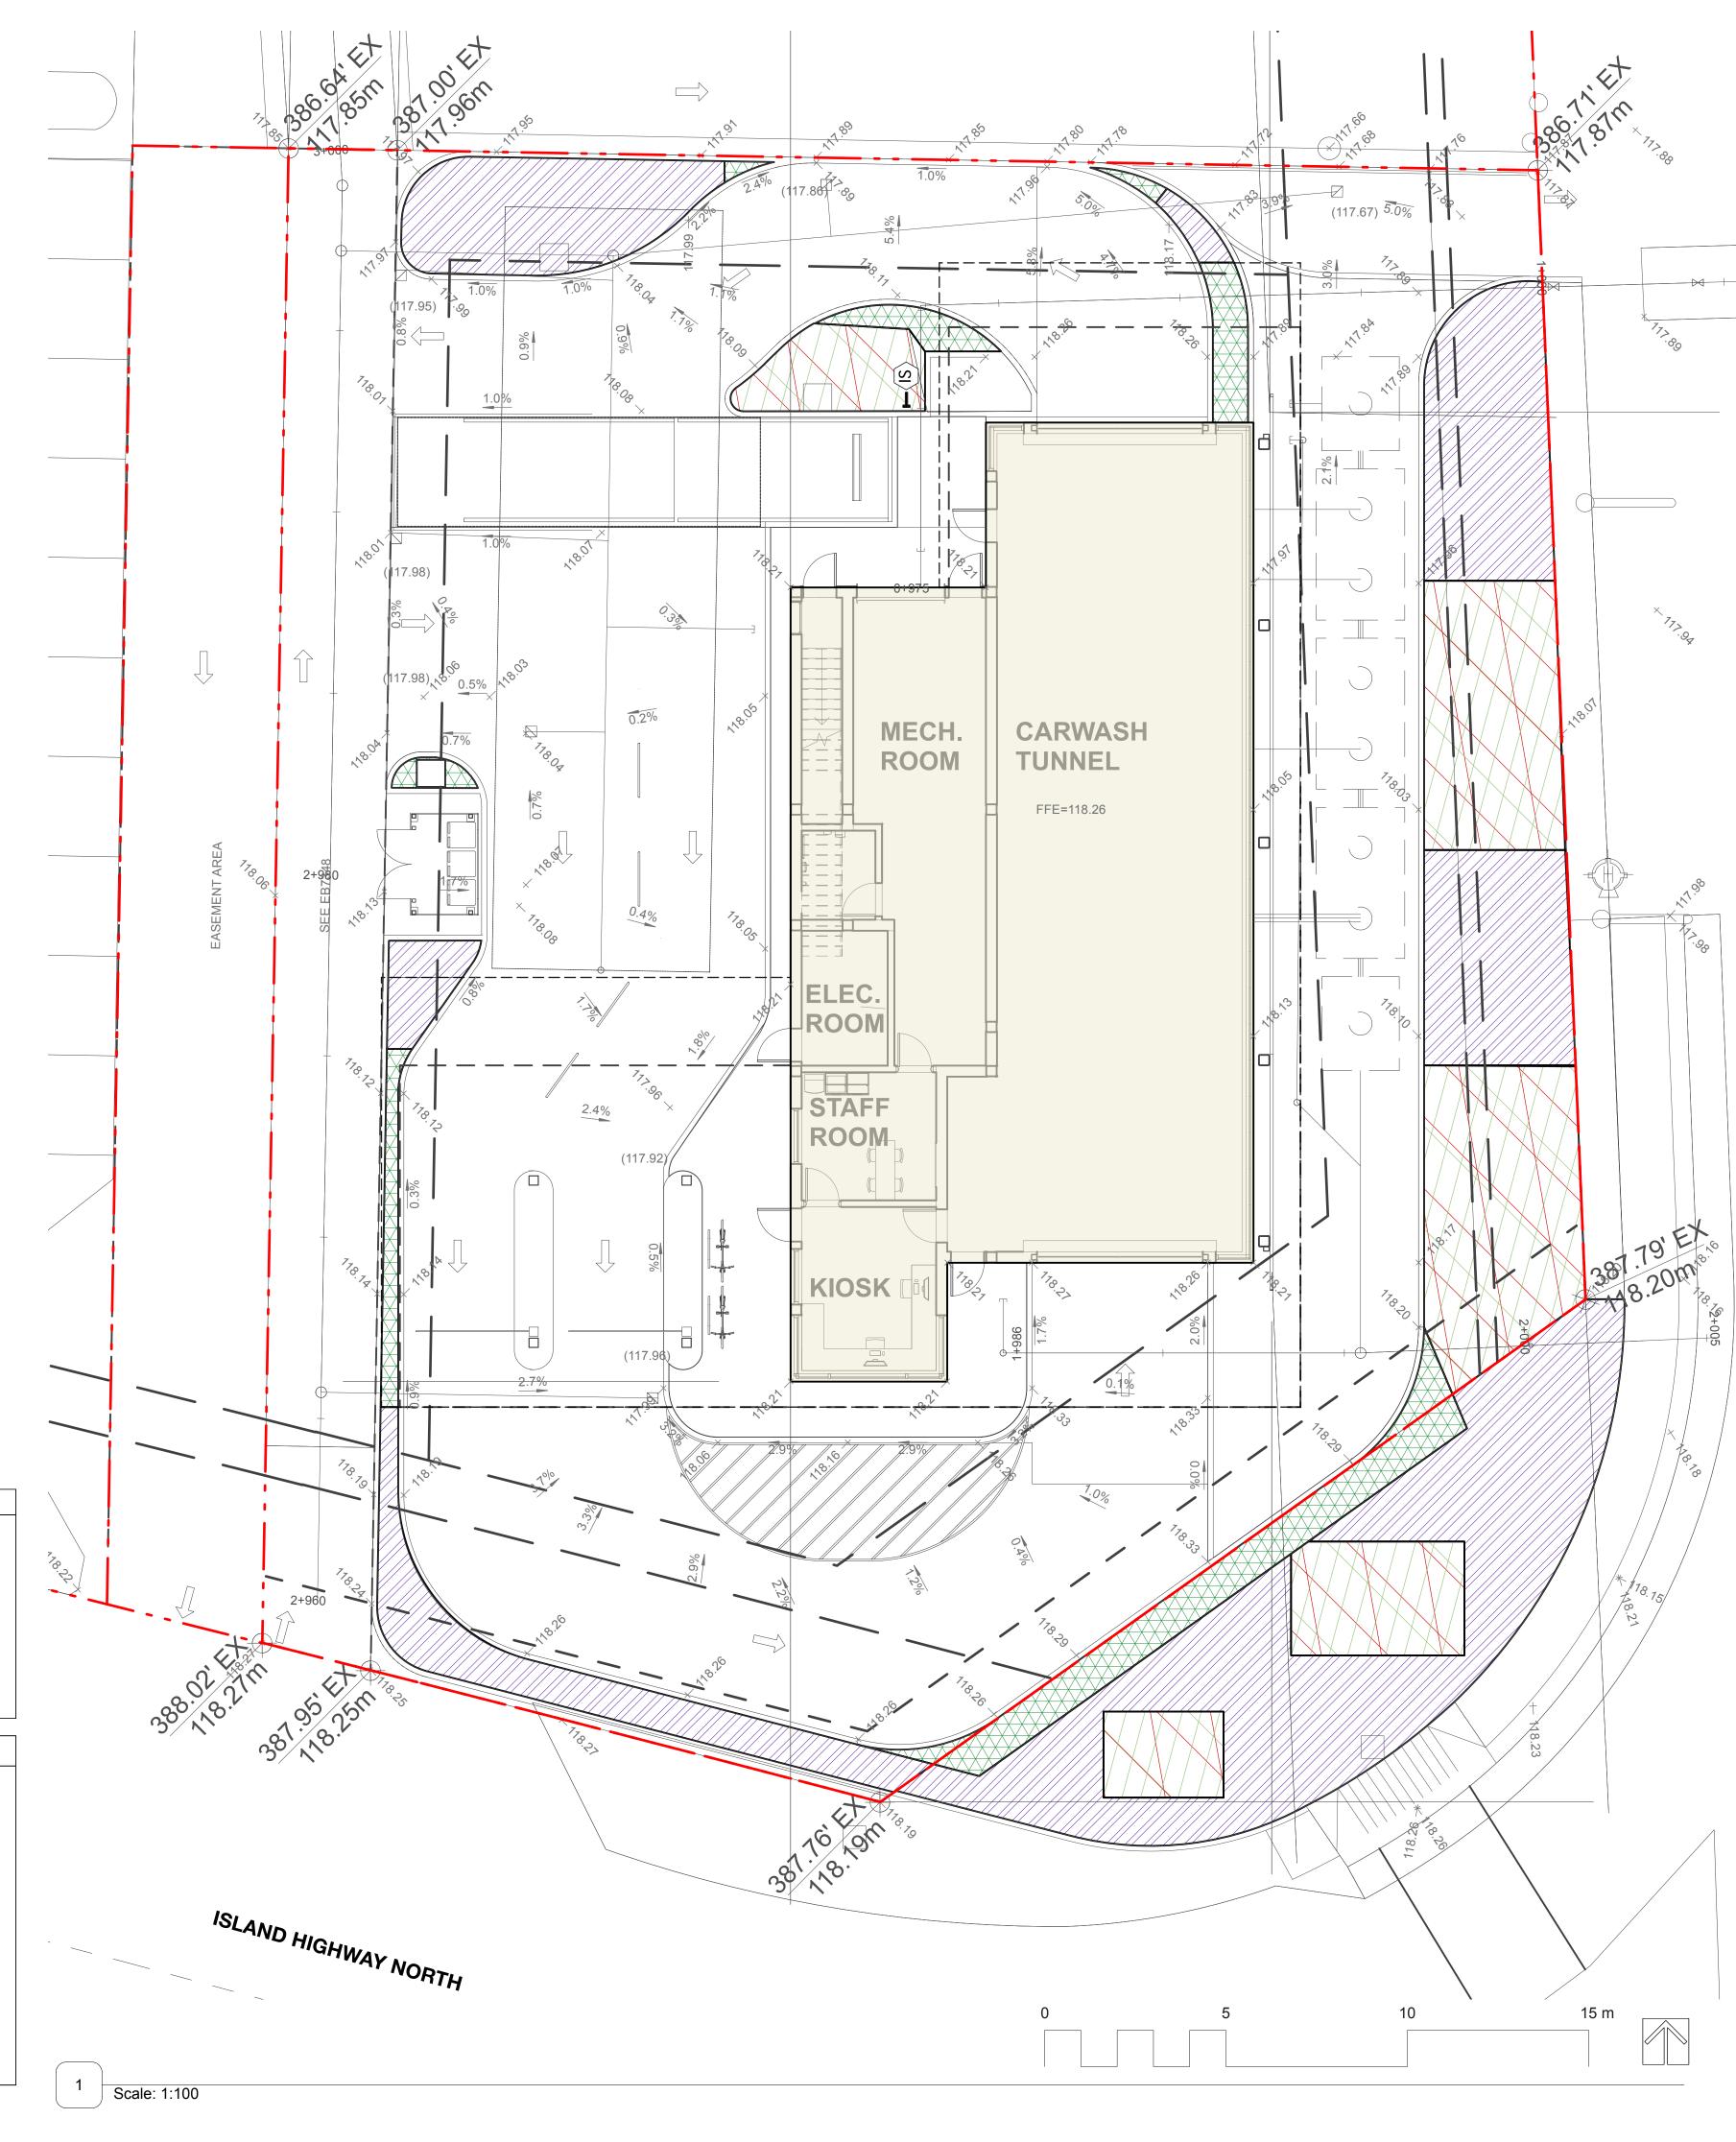Soil Depths & **Irrigated Areas** 

RECEIVED **DP1324** 2024-APR-02
Current Planning

Project Manager 22318 Drawn By Scale N/A KD Reviewed By L3.0

**LEGEND** 

Irrigation Stubout Final location per Mechanical

All planting areas with shrubs and groundcovers to have min. 610mm growing medium
 All planting areas with trees to have min. 915 mm

growing medium

2. All planting areas to be irrigated

2. Irrigation system design as per irrigation design build contractor

PLANTING SOIL DEPTH LEGEND

610 mm (24") Soil Depth 185.25sq.m = 113.00cu.m


32.95 sq.m


915 mm (36") Soil Depth 94.93sq.m = 86.86cu.m

150 mm (6") Drain Rock Depth

All softscape areas to include min. 75mm gravel drainage layers in addition to indicated soil depth for on slab conditions.


2. All onsite planted areas to be irrigated. Irrigation design provided by others, Shop Drawings reviewed by Landscape prior to construction. Offsite irrigation per City standards.

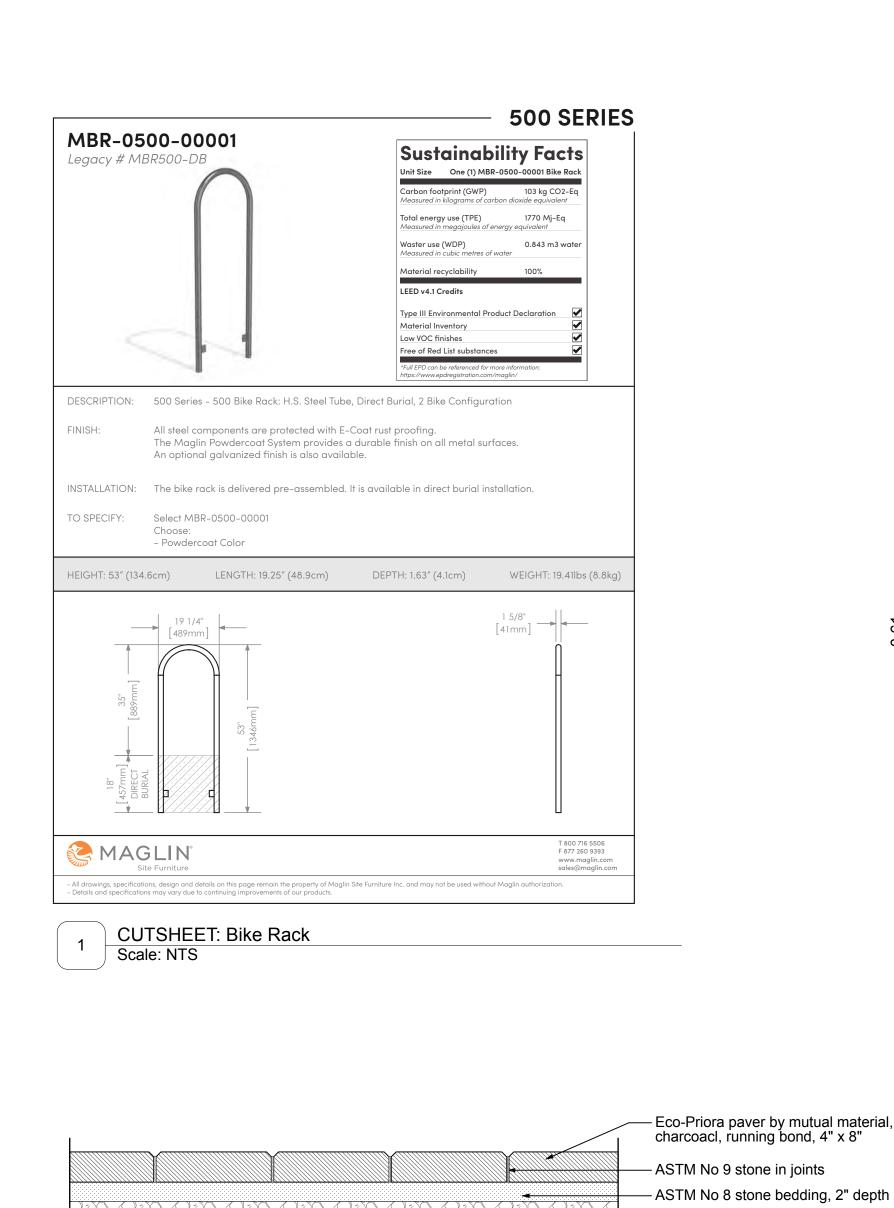


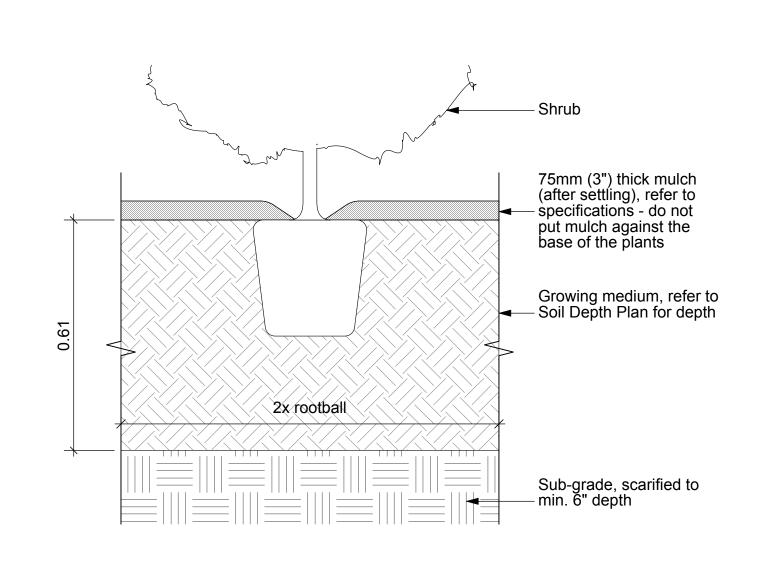

DETAIL: Planting at Grade


Scale: 1:10

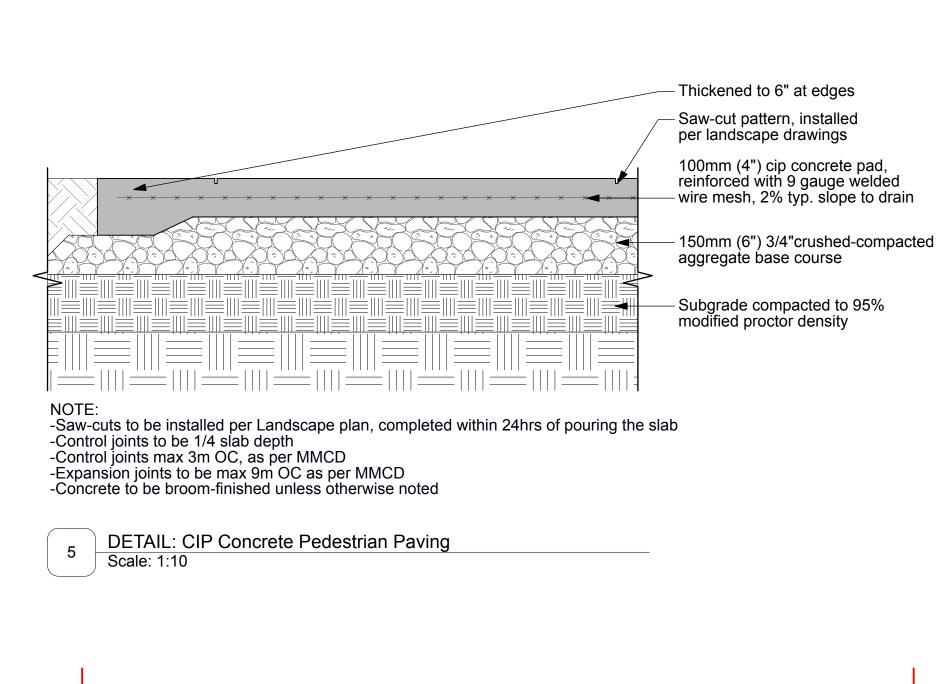

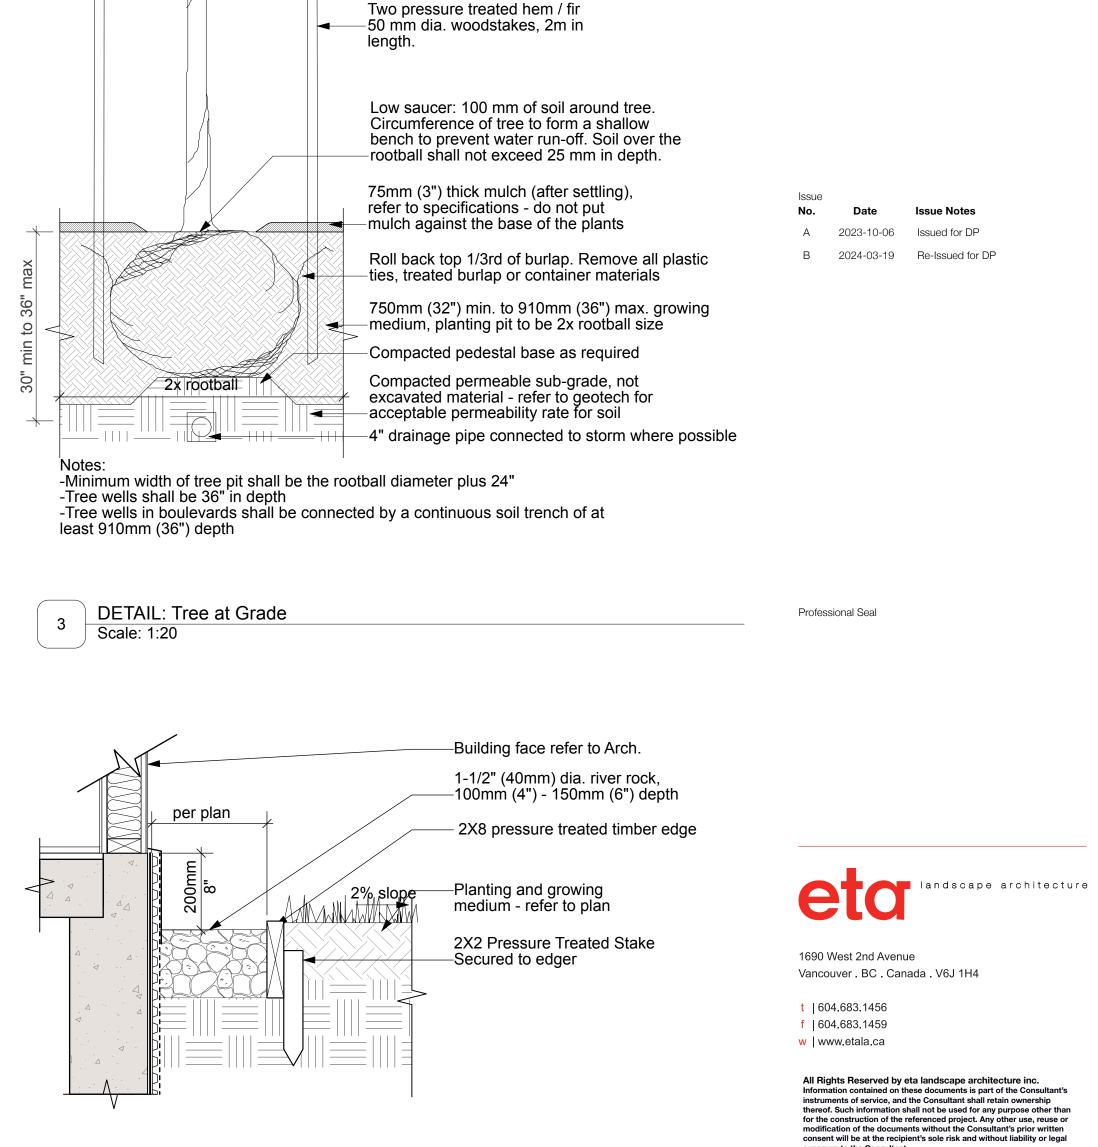

-Prune off broken and damaged branches

—Ties: "arbour tie" or approved alternate

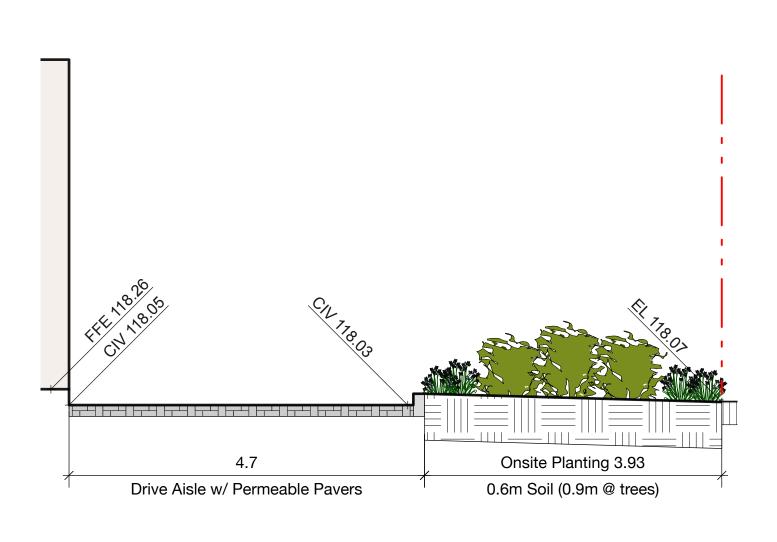



Note: Suggested build-up shown.

Scale: 1:10

**DETAIL: Permeable Pavers** 

Refer to Manufacturer & Civil for permeable paving build-up details.

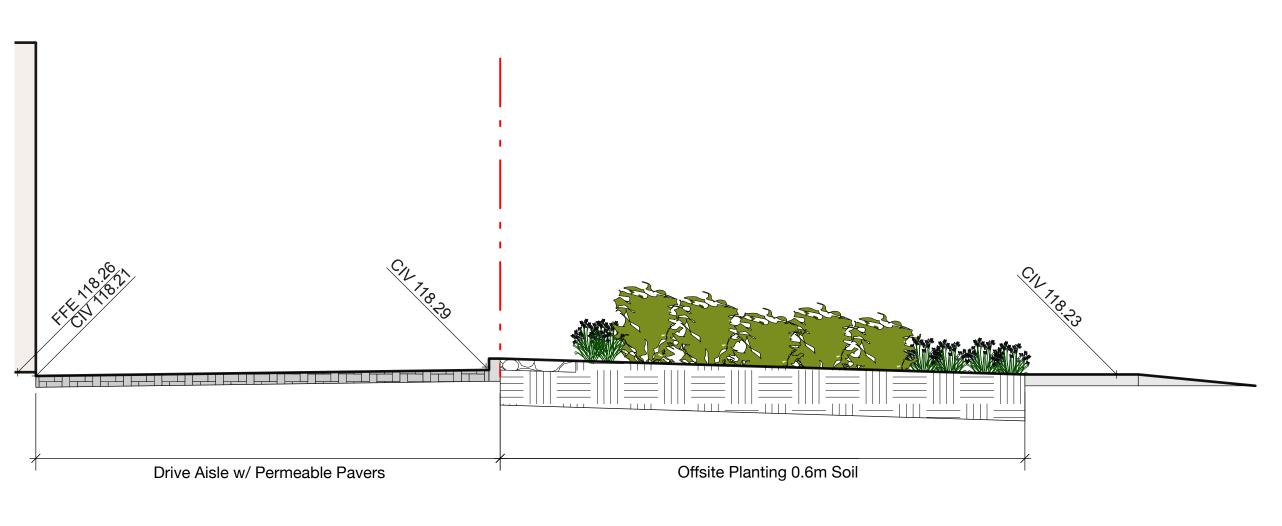

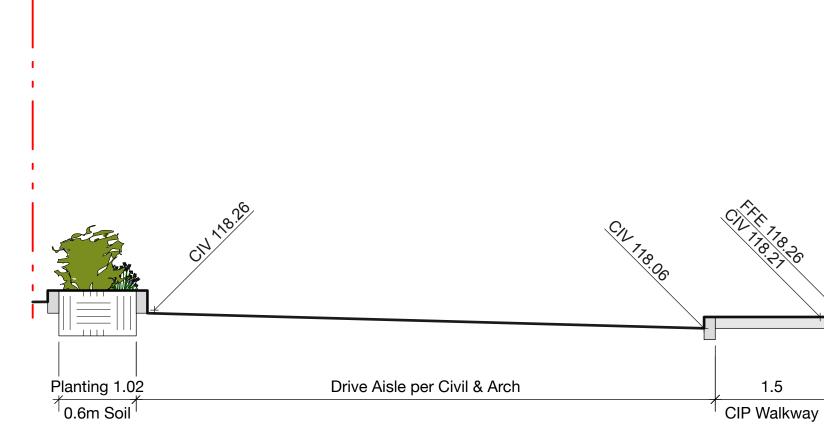

DETAIL: Drain Rock

Scale: 1:10

9 SECTION: South PL Scale: 1:50 Landscape Details
& Sections

RECEIVED

Project

Nanaimo

Drawing Title

Car Wash

3180 Island Highway North

 Project Manager
 Project ID

 KD
 22318

 Drawn By
 Scale

 KD
 AS SHOWN

 Reviewed By
 Drawing No.

 DT
 L4.0

 Date
 5

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 of

**DP1324** 

2024-APR-02

Current Planning

7 SECTION: East PL Scale: 1:50

SECTION: Offsite Planting
Scale: 1:50

- ASTM No 57 stone base, 4" depth

- ASTM No 2 stone subbase, 4" depth

Compacted subgrade, refer to civil